ELECTRICAL SPECIFICATIONS

ELECTRICAL DRAWING LIST

- ELECTRICAL SPECIFICATIONS, LEGEND, & DRAWING LIST
- SITE PLAN PHOTOMETRIC SITE LIGHTING DETAILS
- SITE PLAN ELECTRICAL SINGLE LINE DIAGRAM & SITE ELECTRICAL DETAILS E400

GENERAL

- CONFORM TO THE GENERAL CONDITIONS OF THE CONTRACT. THE ELECTRICAL CONTRACTOR SHALL COORDINATE AND PAY FOR NECESSARY INSPECTION
- PERTAINING TO THE INSTALLATION OF THEIR WORK. WORK MUST BE PERFORMED IN ACCORDANCE WITH THE LATEST EDITION OF THE ONTARIO ELECTRICAL SAFETY CODE, OCCUPATIONAL HEALTH AND SAFETY ACT, AND LOCAL CODES,
- AND LOCAL CODES. DO NOT REDUCE THE STANDARDS ESTABLISHED BY THE DRAWINGS AND SPECIFICATIONS BY APPLYING ANY OF THE CODES REFERRED TO HEREIN.
- PROVIDE ALL MATERIALS AND DEVICES, ALL LABOUR AND TOOLS, AS WELL AS ANY MISCELLANEOUS MATERIALS REQUIRED TO COMPLETE THE WORK INDICATED ON THE DRAWINGS AND

MATERIALS SHALL CONFORM TO THE LATEST EDITION OF THE CANADIAN STANDARDS ASSOCIATION,

- IN THESE SPECIFICATIONS. ELECTRICAL EQUIPMENT IS SHOWN NOT TO SCALE (N.T.S.) ON DRAWINGS.
- ALL ELECTRICAL WORK SHALL BE PERFORMED BY LICENSÉD ELECTRICIANS HOLDING A VALID CERTIFICATE OF QUALIFICATION.
- CONTRACTOR SHALL MAKE A PERSONAL SITE VISIT TO CONFIRM ALL QUANTITIES, LOCATIONS, AND ARRANGEMENTS BEFORE PROCEEDING WITH THE WORK. CLAIMS FOR EXTRAS WILL NOT BE ACCEPTED FOR WORK RESULTING FROM CONDITIONS THAT WOULD HAVE BEEN EVIDENT UPON
- THOROUGH EXAMINATION OF THE SITE. REPAIR OR PAY FOR ALL DAMAGE TO THE BUILDING INCURRED BY THE WORK OF THIS DIVISION. 10. THE OWNER'S PROPERTY MUST BE KEPT IN TIDY CONDITION. PROMPTLY REMOVE GARBAGE FROM
- COORDINATE THE INSTALLATION OF WORK WITH OTHER TRADES. THE ELECTRICAL CONTRACTOR
- SHALL BE RESPONSIBLE FOR THE PROPER LAYOUT OF EQUIPMENT AND MATERIALS AND ENSURING THERE ARE NO INTERFERENCES WITH OTHER SYSTEMS. 12. THE ELECTRICAL CONTRACTOR SHALL BE RESPONSIBLE FOR EXCAVATION AND BACK FILL REQUIRED
- PROPERLY COMPACTED EQUIPMENT SHALL BE INSTALLED. TESTED. AND ADJUSTED AS PER THE MANUFACTURER'S INSTRUCTIONS, AND AS NECESSARY TO ENSURE OPTIMUM PERFORMANCE. EQUIPMENT SHALL BE

FOR THE INSTALLATION OF UNDERGROUND WORK. BACK FILL MATERIAL MUST BE CLEAN AND

- INSTALLED TO ALLOW FOR EASY ACCESS AND MAINTENANCE. THE ELECTRICAL CONTRACTOR SHALL GUARANTEE WORK PERFORMED UNDER THIS CONTRACT FOR
- A PERIOD OF TWO (2) YEARS FROM THE DATE OF SUBSTANTIAL COMPLETION. MATERIALS AND EQÙIPMENT SHALL BE NEW AND TOP QUALITY, EXCEPT WHERE NOTED OTHERWISE. THIS SPECIFICATION SHALL BE CONSIDERED TO BE THE BASE BID SPECIFICATION AND CONTRACTORS MUST CARRY THE BASE BID MANUFACTURER'S IN THEIR QUOTATION. ALTERNATE MANUFACTURER'S OF EQUIPMENT CAN ONLY BE OFFERED AS PROPOSED ALTERNATES WITH THE
- CORRESPONDING PRICE REDUCTIONS CLEARLY SHOWN ON A SEPARATE SHEET IF NECESSARY. THE INTENT OF THESE DRAWINGS AND SPECIFICATIONS IS TO PROVIDE A COMPLETE AND OPERATIONAL SYSTEM TO THE OWNER SUPPLIED AND INSTALLED BY THE ELECTRICAL CONTRACTOR.
- ERRORS OR OMISSIONS IN THE DRAWINGS OR SPECIFICATIONS SHALL BE BROUGHT TO THE ATTENTION OF THE CONTRACT ADMINISTRATOR IMMEDIATELY.
- 19. ENSURE THAT ALL EQUIPMENT SUPPLIED IS SUITABLE FOR THE RESPECTIVE VOLTAGE.

TEMPORARY FACILITIES AND WASTE DISPOSAL

PROVIDE TEMPORARY STORAGE AS REQUIRED FOR ELECTRICAL CONSTRUCTION EQUIPMENT AND MATERIALS. THE ELECTRICAL CONTRACTOR IS RESPONSIBLE FOR STORAGE AND SECURITY OF MATERIALS AND EQUIPMENT ON THE JOB SITE.

REMOVE ALL CONSTRUCTION WASTE FROM SITE. APPLY WASTE MANAGEMENT FOR REDUCTION, RECYCLING AND REUSE.

SUBMITTALS

- SUBMIT SHOP DRAWINGS OR PRODUCT DATA SHEETS, AS APPROPRIATE, TO CONTRACT
- ADMINISTRATOR FOR ALL ELECTRICAL EQUIPMENT AND DEVICES. CHANGES TO THE CONTRACT RESULTING FROM UNFORESEEN SITE CONDITIONS, OR CHANGES REQUIRED BY ANY AND ALL AUTHORITIES HAVING JURISDICTION SHALL BE SUBMITTED TO THE CONSULTANT.
- ONE (1) FULL SIZE SET OF AS-BUILT DRAWINGS AND SPECIFICATIONS SHALL BE MARKED AND
- SUBMITTED TO THE CONTRACT ADMINISTRATOR. CERTIFICATE OF INSPECTION AND APPROVAL FROM THE ELECTRICAL SAFETY AUTHORITY SHALL BE SUBMITTED TO THE CONTRACT ADMINISTRATOR.
- PROVIDE OPERATION AND MAINTENANCE (O&M) MANUALS, TEST RESULTS, CERTIFICATES, AND WARRANTIES. CONTRACTOR SHALL CREATE FIRST PAGE WITH CHART CLEARLY SHOWING REQUIRED MAINTENANCE ACTIVITIES AND ASSOCIATED SCHEDULE PER MANUFACTURER'S RECOMMENDATIONS.

GENERAL PRODUCT REQUIREMENTS

- ALL MATERIAL SHALL BE COMMERCIAL GRADE, NEW, WITHOUT DEFECT, AND C.S.A. APPROVED INCLUDING CONTROL PANEL AND COMPONENT ASSEMBLIES UNLESS NOTED OTHERWISE. PROVIDE APPROPRIATE ACCESSORIES TO COMPLETE THE INSTALLATION INCLUDING, BUT NOT
- LIMITED TO FASTENINGS, SUPPORTS, CONNECTORS, SEALANTS. ALL CONDUCTORS SHALL BE COPPER UNLESS NOTED OTHERWISE.
- REMOVE BURRS AND SHARP EDGES. PROVIDE SPARE PARTS IN ACCORDANCE WITH MANUFACTURER'S RECOMMENDATIONS.

PAINT, FINISHES LABELING, AND SIGNAGE

- PROVIDE CERTIFICATION LABELS AND WARNING SIGNAGE IN ACCORDANCE WITH THE ELECTRICAL
- PROVIDE LABELS ON ELECTRICAL DISTRIBUTION EQUIPMENT TO WARN PERSONS OF POTENTIAL ELECTRIC SHOCK AND ARC FLASH HAZARDS. THE OWNER SHALL PROVIDE ARC FLASH RATINGS
- CLEARLY IDENTITY ALL DISTRIBUTION PANELS WITH LAMACOID LABELS. PROVIDE COMPLETE, CLEARLY LEGIBLE PANEL DIRECTORY MOUNTED INSIDE THE DOOR OF EACH DISTRIBUTION PANEL. DETERMINE ALL LOADS AND INCLUDE IN PANEL DIRECTORY.

ELECTRICAL EXECUTION REQUIREMENTS

- PROVIDE APPROPRIATE ACCESSORIES TO COMPLETE THE INSTALLATION INCLUDING, BUT NOT
- LIMITED TO FASTENINGS, SUPPORTS, CONNECTORS, SEALANTS. INSTALL ALL MATERIALS IN A NEAT WORKMAN LIKE MANNER, PLUMB, SQUARE AND STRAIGHT WITH
- RESPECT TO BUILDING LINES.
- MAINTAIN PHASE SEQUENCE AND COLOUR CODING. ENSURE THAT SLEEVES AND OPENINGS FOR THIS DIVISION ARE INSTALLED IN FOOTINGS,

WORKING AND ACCESS SPACE OF OTHER EQUIPMENT;

7.3. SUCH THAT NAMEPLATES AND LABELS ARE VISIBLE.

- FOUNDATIONS, AND SLABS BEFORE CONCRETE IS POURED. BE PRESENT DURING EXCAVATING AND BACKFILLING WORK WHERE ELECTRICAL SERVICES ARE INSTALLED-ENSURE ROUTE, DEPTH, AND BACKFILL MATERIALS ARE AS SPECIFIED. PROVIDE MARKING TAPES. ARRANGE INSPECTIONS PRIOR TO BACKFILL.
- COORDINATE THE INSTALLATION OF REQUIRED SUPPORTING DEVICES AND SET SLEEVES IN CAST-IN-PLACE CONCRETE, MASONRY WALLS, AND OTHER STRUCTURAL COMPONENTS AS THEY ARE CONSTRUCTED.
- COORDINATE ARRANGEMENT, MOUNTING AND SUPPORT OF ELECTRICAL EQUIPMENT: 7.1. TO PROVIDE FOR EASE OF MAINTENANCE, OPERATION OF DOORS AND ACCESS POINTS OF THE EQUIPMENT WITH MINIMUM INTERFERENCE TO OTHER INSTALLATIONS; 7.2. SUCH THAT RACEWAYS, CABLES, WIREWAYS WILL BE CLEAR OF OBSTRUCTIONS AND OF THE

- RACEWAY, PULL BOXES, AND ENCLOSURES
- CLEAN CONDUIT OF OBSTRUCTIONS BEFORE PULLING WIRE. PROVIDE KNOCK-OUT PLUGS AND COVER PLATES TO COVER ALL REMAINING OPENINGS ON PANELS
- ENSURE WEATHERPROOF ENCLOSURES ARE SEALED TIGHT EXCEPT FOR ANY APPROPRIATE DRAIN
- HOLES OR VENTS. PROVIDE BUSHINGS FOR PIPE SLEEVES TO PROTECT EMERGING CONDUCTORS.

FALLING DEBRIS, OR OTHER CONTAMINANTS DURING CONSTRUCTION.

- PROVIDE SLEEVES FOR PENETRATIONS UNLESS CORE-DRILLED HOLES OR FRAMED OPENINGS ARE
- SEAL SPACE OUTSIDE OF SLEEVES WITH GROUT. PROMPTLY PACK GROUT SOLIDLY BETWEEN SLEEVE AND WALL SO NO VOIDS REMAIN. TOOL EXPOSED SURFACES SMOOTH; PROTECT GROUT WHILE CURING. PROVED WEATHERPROOF SEALS FOR EXTERIOR PENETRATIONS.
- TEMPORARILY SEAL CONDUIT ENDS WHERE EXPOSED TO DIRT, FIBERS OR FLYINGS, WATER, OR FALLING DEBRIS DURING CONSTRUCTION.
- USE FITTINGS WITH EQUAL PROTECTION TO ENCLOSURE TYPE TO SEAL OUT WATER/OIL. 9. PROTECT ENCLOSURES WITH SEALS/COVERS WHERE EXPOSED TO DIRT, FIBERS OR FLYINGS, WATER,

PANELBOARDS

1. COVER EXPOSED PANELS TO PROTECT FROM DUST, PAINT AND OTHER CONTAMINANTS DURING CONSTRUCTION. CLEAN OUT DUST AND DEBRIS BEFORE ENERGIZING.

WIRES AND CABLES


- ALL CONDUCTORS: COPPER. CONDUCTORS #14AWG AND LARGER: STRANDED.
- PULL CABLE IN ACCORDANCE WITH MANUFACTURER'S RECOMMENDATIONS, USING CABLE GRIPS AND LUBRICANT SUITABLE FOR THE TYPE OF CABLE.

GROUNDING AND BONDING

- GROUNDING REQUIREMENTS ARE GENERALLY NOT SHOWN ON THE DRAWINGS. PROVIDE ALL GROUNDING PER THE LATEST ONTARIO ELECTRIC SAFETY CODE (OESC), ELECTRICAL SAFETY AUTHORITY (ESA) OR ANY OTHER LOCAL AUTHORITY REGARDLESS OF WHETHER IT HAS BEEN SHOWN, THIS INCLUDES EQUIPMENT GROUNDING AS WELL AS SYSTEM (SERVICE) AND DISTRIBUTION GROUNDING, PROVIDE ADDITIONAL SPECIFIC PROVISIONS AS INDICATED, INCLUDING GROUND CONNECTIONS. PROVIDE THESE INSTALLATIONS TO ELECTRICAL SAFETY CODE REGULATIONS. COLLECT ALL GROUNDING CONNECTIONS AT A COMMON POINT WHICH IN TURN IS CONNECTED TO THE MAIN SERVICE GROUND.
- ARRANGE GROUNDS SUCH THAT UNDER NORMAL OPERATION CONDITIONS CURRENT FLOW IN ANY GROUND CONDUCTOR IS NOT OBJECTIONABLE AND WILL NOT HARM PERSONNEL OR EQUIPMENT. ARRANGE SERVICE GROUNDS AND DISTRIBUTIONS GROUND RESISTANCE READINGS WITHIN VALUES REQUIRED BY THE ELECTRICAL SAFETY CODE.

FIELD QUALITY CONTROL

- CAREFULLY CHECK WIRING FOR EACH SYSTEM TO ENSURE THAT THE SYSTEM WILL FUNCTION PROPERLY AS INDICATED BY WIRING AND SCHEMATIC DIAGRAMS AND DESCRIPTION OF OPERATION. TEST THE ELECTRICAL INSTALLATION FOR PROPER AND SAFE OPERATION IN ACCORDANCE WITH
- THE INTENT OF THE DRAWINGS AND SPECIFICATIONS. REPLACE COMPONENTS DAMAGED DURING TESTING AT NO ADDITIONAL COST TO THE OWNER
- MEGGER ALL POWER CIRCUITS 600V AND ABOVE.
- INSTRUCT OWNER OR OWNER'S REPRESENTATIVE IN OPERATION OF SYSTEMS.

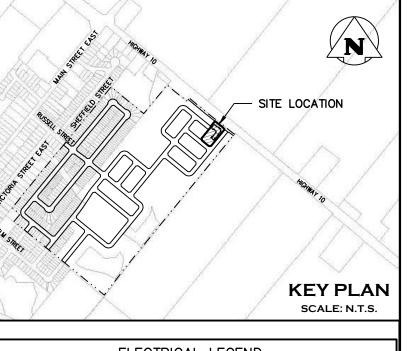


	ELECTRICAL LEGEND		
	<u>LIGHTING</u>		
- <u></u>	PROPOSED POLE MOUNTED LIGHT FIXTURE		
<□□□>	PROPOSED POLE MOUNTED LIGHT FIXTURES MOUNTED AT 180°		
$\hat{\Box}$	PROPOSED WALL PACK		
-	PROPOSED SUBDIVISION LIGHT FIXTURE		
	POWER & SYSTEMS		
	PAD-MOUNTED TRANSFORMER		
	SWITCHGEAR		
^ ∠ -→	GROUNDING RODS		
X	CONCRETE ENCASED DUCT BANK (X DENOTES NUMBER OF DUCTS)		
D#	DUCT NUMBER		
[0]	CCTV CAMERA		
•	PROPOSED TEMPORARY SERVICE HYDRO POLE		
<u>LINETYPES</u>			
	PROPERTY LINE		
	PRIMARY CABLE RED, WHITE, & BLUE		
	SECONDARY CABLE		
x x x	PROPOSED FENCE		
	<u>ABBREVIATIONS</u>		
D.B.	DIRECT BURIED		
C.E.	CONCRETE ENCASED		
МН	MOUNTING HEIGHT		
I.G.	ISOLATED GROUNDING		
I.T.	INFORMATION TECHNOLOGY		
EX	EXISTING		
EQ.	EQUAL		

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- PROJECT.
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2	ISSUED FOR 3RD SUBMISSION	24/04/2023	





DUNDALK COMMERCIAL BLOCK TOWNSHIP OF SOUTHGATE


ELECTRICAL SPECIFICATIONS, LEGEND, & DRAWING

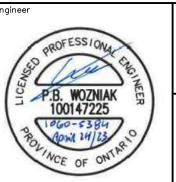


Drawn By		Design By		Project	1000 E704
	B.A.O.		B.A.O./I.S.		1060-5384
Scale		Check By		Drawing	F001
	N.T.S.		P.W.		EUUT

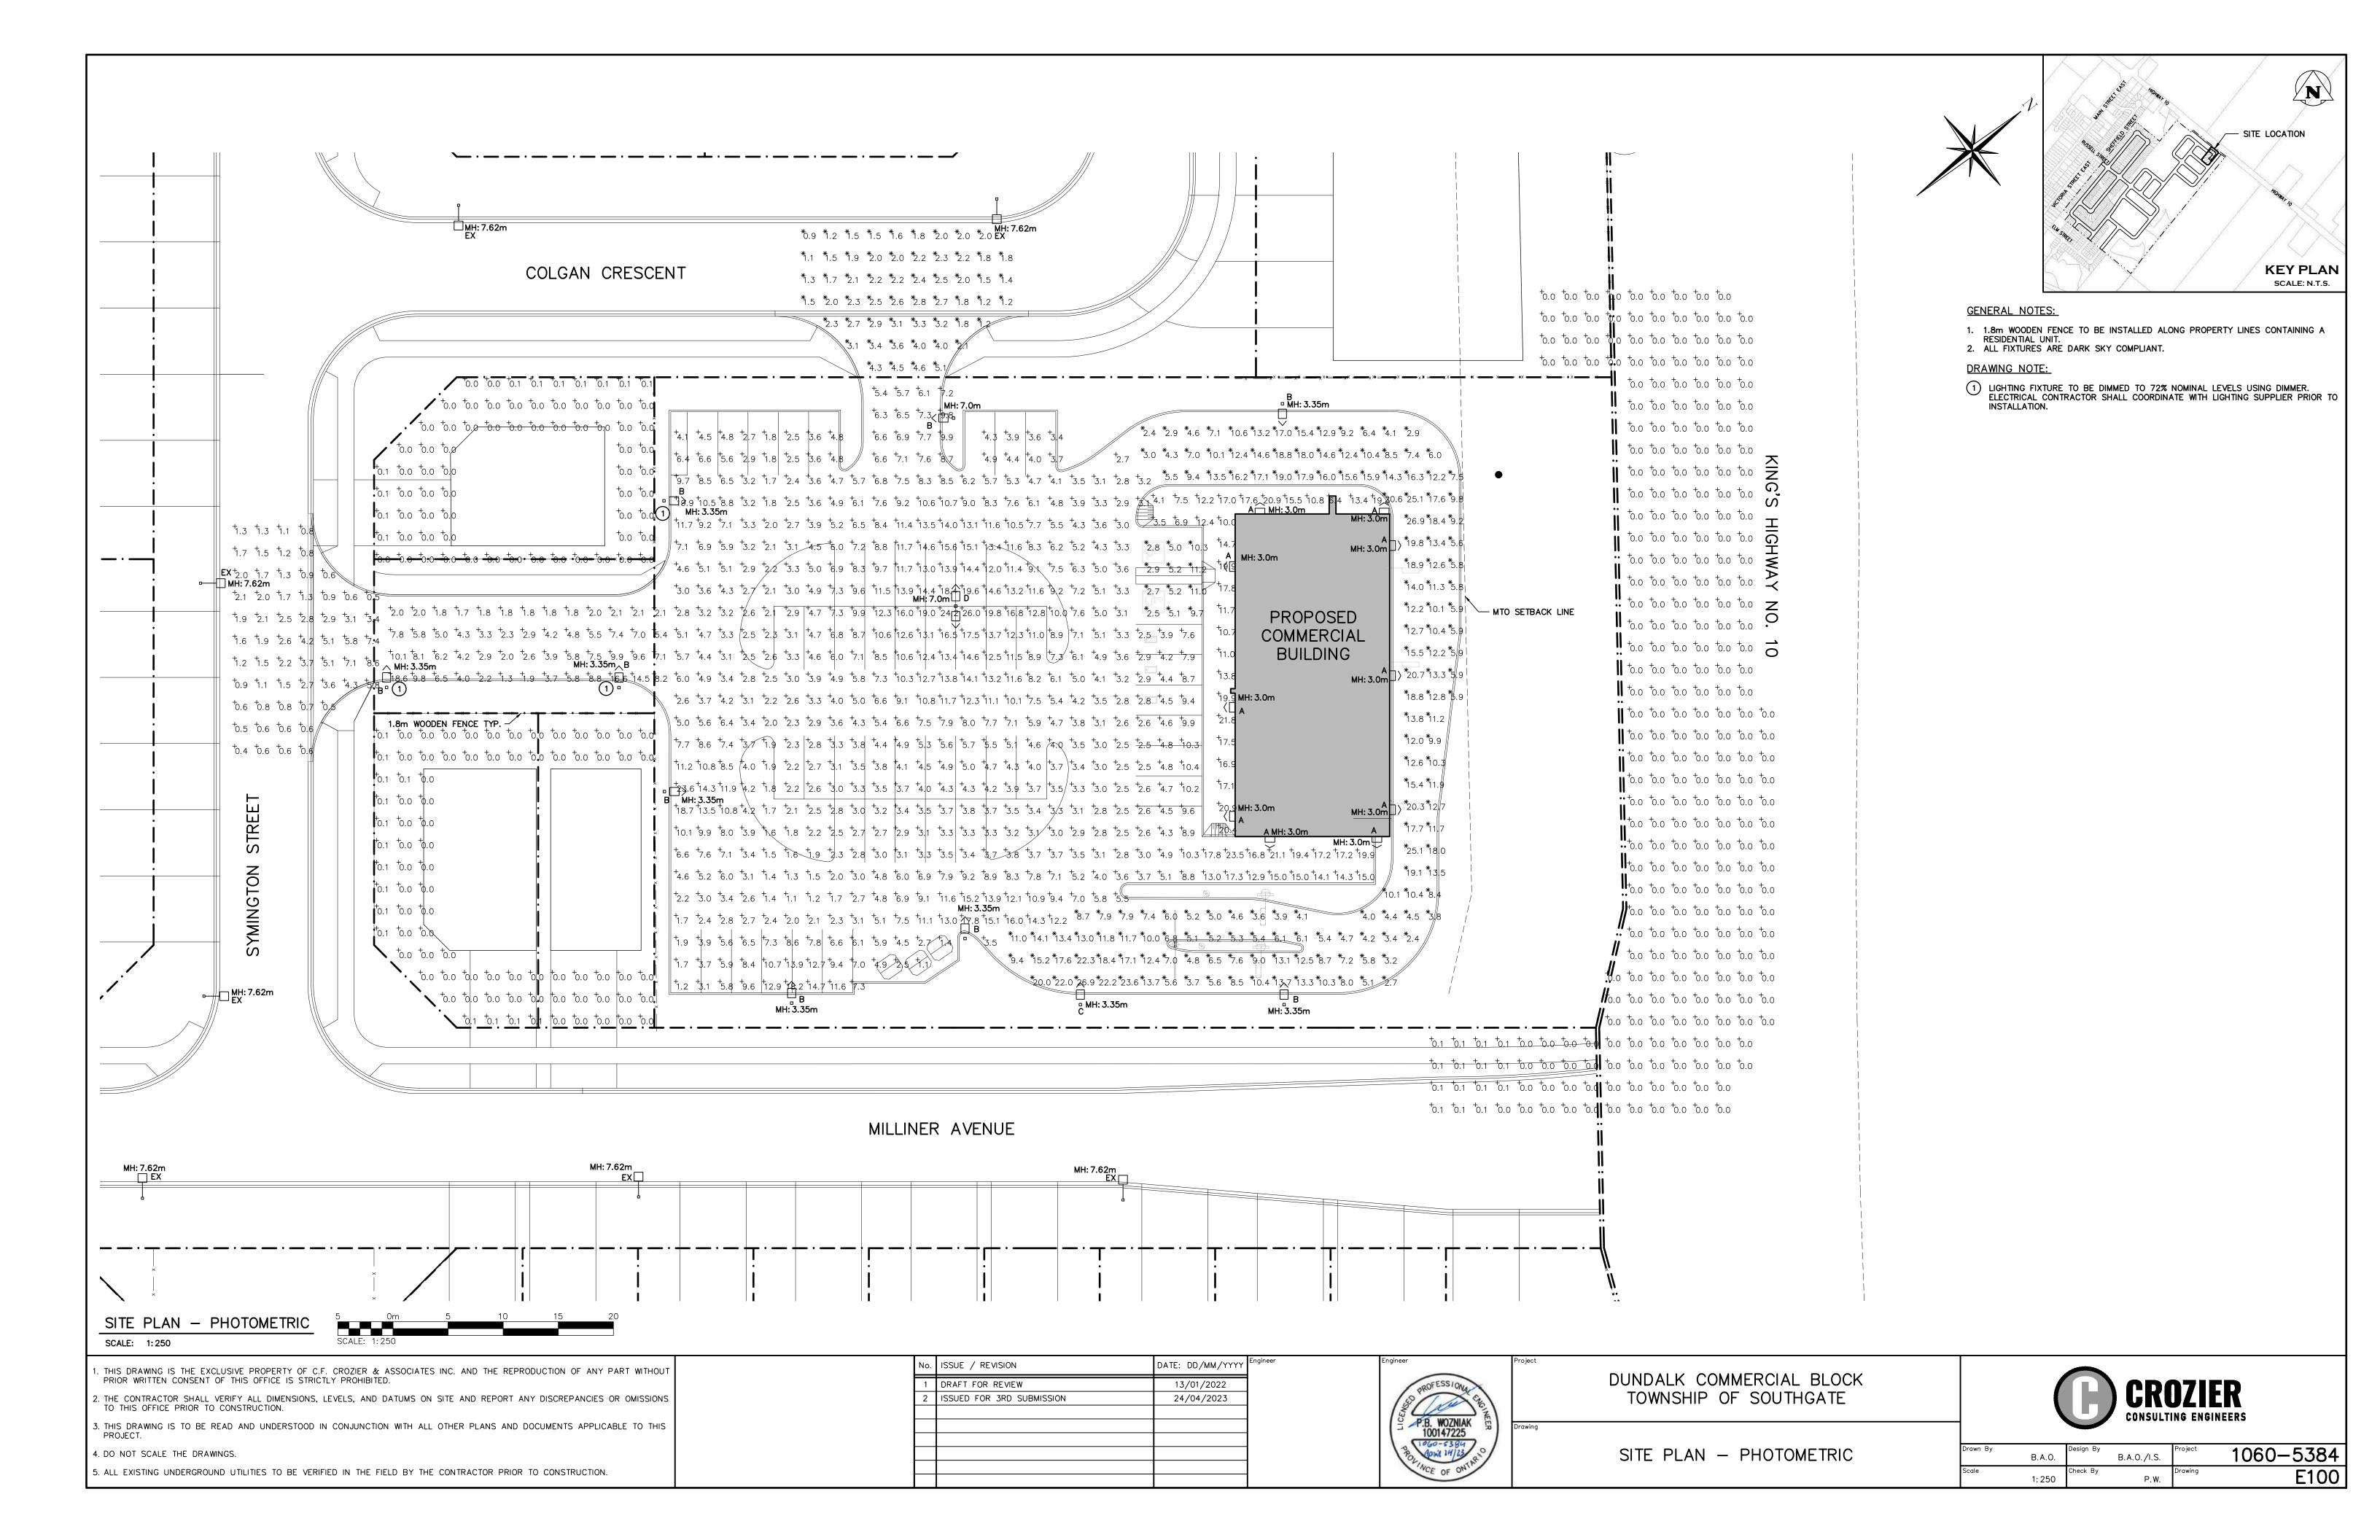

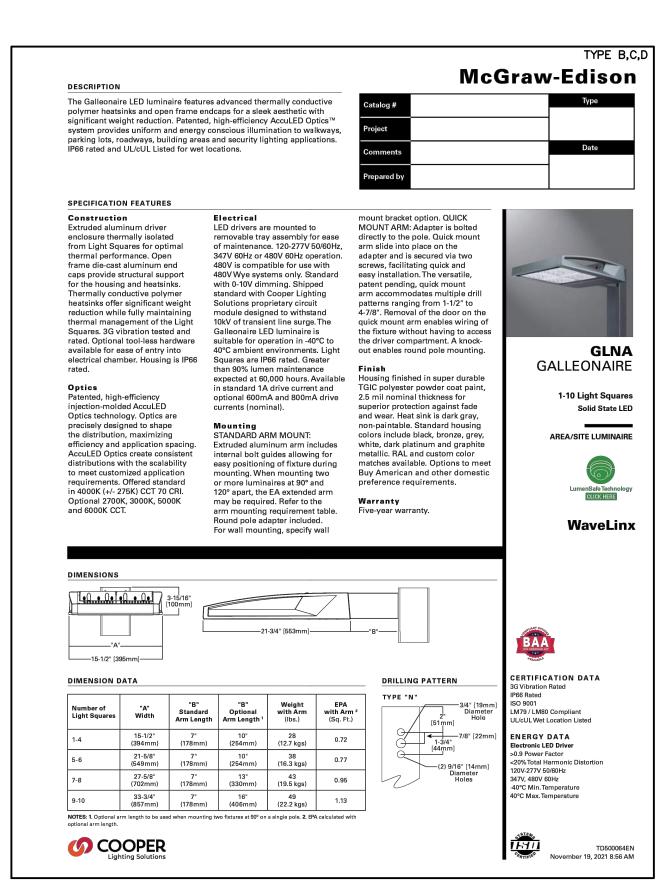

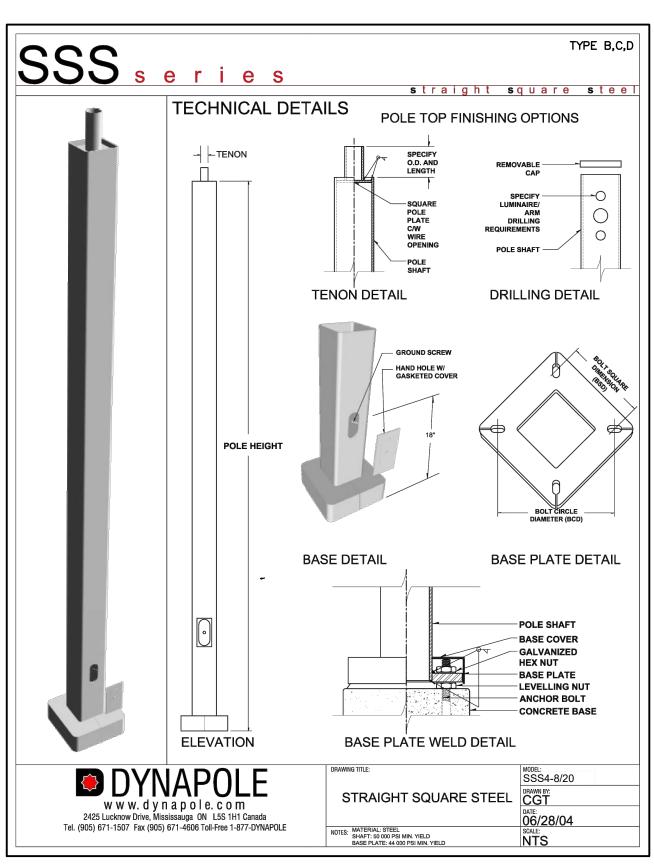



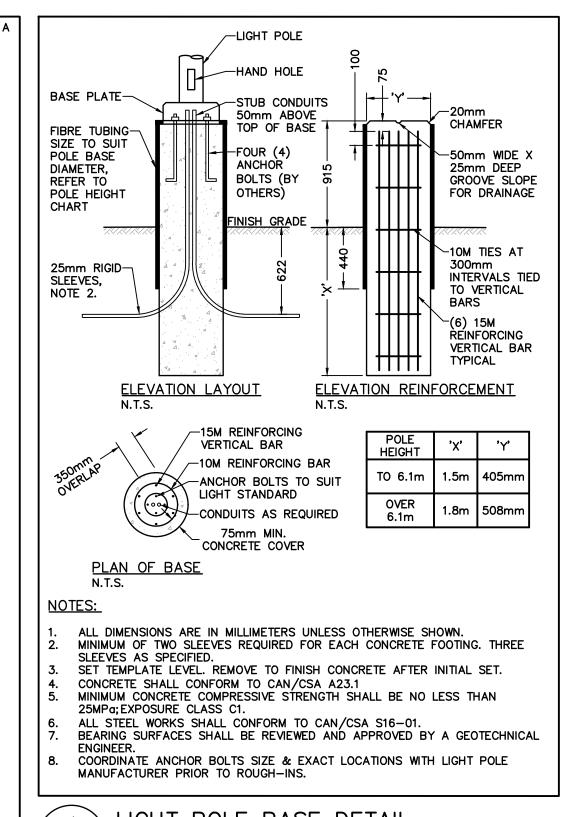

LIGHT POLE BASE DETAIL

E101 SCALE : N.T.S.

	LUMINAIRE SCHEDULE									
SYMBOL	LABEL	MANUFACTURER	CATALOG NUMBER	LIGHT LOSS FACTOR	DIMMING LIGHT LOSS FACTOR	MOUNTING HEIGHT	WATTAGE	DESCRIPTION		
	А	COOPER	GAW-SA2C-740-U-T3-BK-PR7	0.85	N/A	MOUNNTED AT 3.0m (9.8')	113W	GAW GALLEON WALL PACK, 113W, WITH TYPE T3 DISTRIBUTION		
□□>	В	COOPER	GLNA-AF-03-LED-E1-SL3-BK-PER7-HSS	0.85	0.612	MOUNTED ON 2.4m (8') OR 6.1m (20') POLE ON 0.9m (3') CONCRETE BASE. SEE SHEET E100 FOR MOUNTING HEIGHT	166W	GLNA GALLEONAIRE LED AREA FIXTURE, 166W, WITH TYPE SL3 DISTRIBUTION, C/W HOUSE SIDE SHIELD. MOUNTED ON A SQUARE STEEL POLE.		
□ □>	С	COOPER	GLNA-AF-06-LED-E1-SL4-BK-DIM-PER7-HSS	0.85	N/A	MOUNTED ON 2.4m (8') POLE ON 0.9m (3') CONCRETE BASE	333W	GLNA GALLEONAIRE LED AREA FIXTURE, 333W, WITH TYPE SL4 DISTRIBUTION, C/W HOUSE SIDE SHIELD. MOUNTED ON A SQUARE STEEL POLE.		
<□□□>	D	COOPER	GLNA-AF-10-LED-E1-T4FT-BK-PER7	0.85	N/A	MOUNTED ON 6.1m (20') POLE ON 0.9m (3') CONCRETE BASE	2×558W	GLNA GALLEONAIRE LED AREA FIXTURE, 558W, WITH TYPE T4FT DISTRIBUTION. MOUNTED ON A SQUARE STEEL POLE BACK-TO-BACK AT 180°.		
<u> </u>	(EX) EXISTING	PHILIPS	RFS-54W16LED-3K-G2-R2M-UNV-DMG-API- RCD7-SP2-PH8-HS-GY3	0.86	N/A	MOUNTED ON 9.1m (30') USI POLE AT 7.62m (25') AND ON A 1.8m (6') ARM MAST	54W	RFS LED STREETLIGHT, SMALL, TYPE II MEDIUM, 54W, 3000K, C/W HOUSE SIDE SHIELD, LUMINAIRES MOUNTED AT 7.62m (25') ABOVE FINISHED GRADE ON 1.8m (6') ARM. INSTALLED DURING EDGEWOOD GREEN PHASE 11.		

THE FOLLOWING NOTATIONS APPLY TO ALL LUMINAIRES IN SCHEDULE, UNLESS OTHERWISE NOTED:


- ALL LUMINAIRES SHALL UTILIZE HIGH POWER FACTOR.
- ALL LED LUMINAIRES SHALL HAVE AT LEAST 50,000 HOURS WARRANTY INCLUDING DRIVERS. ALL LUMINAIRES COLOUR TEMPERATURE SHALL BE 4000K, UNLESS OTHERWISE NOTED.
- 3. ALL LUMINAIRES SHALL BE DARK SKY COMPLIANT.

LUMINAIRE STATISTICS							TARGET VALUES		
LABEL	LABEL SYMBOL UNITS AVG MAX MIN AVG/MIN							AVG	AVG/MIN
ACCESSIBLE PARKING	*	Fc	6.1	11.2	2.5	2.5:1	N/A	6.0	5.0:1
BUILDING WALKWAY	+	Fc	14.2	21.8	3.5	4.1:1	N/A	10.0	5.0:1
DRIVE THRU	*	Fc	11.0	26.9	2.4	4.6:1	N/A	10.0	5.0:1
PARKING LOT	×	Fc	6.4	26.0	1,1	5.8:1*	N/A	6.0	5.0:1
SOUTH ENTRANCE	+	Fc	2.1	8.6	0.4	5.3:1	LOCAL/HIGH	1,7	6.0:1
WEST ENTRANCE	*	Fc	2.3	5.1	0.9	2.6:1	LOCAL/HIGH	1.7	6.0:1
PROPERTY LINE	+	Fc	0.0	0.1**	0.0	N/A	N/A	0.0	N/A

GENERAL NOTES:

- (*) PLEASE NOTE THAT THE UNIFORMITY AVG/MIN IS EXCEEDING THE TARGET VALUES DUE TO LOW ILLUMINATION POINTS AT THE EXTREMITIES OF THE AREA, IN ORDER TO ELIMINATE LIGHT SPILL ONTO THE NEIGHBORING PROPERTIES.
- 2. (**) PLEASE NOTE THAT SPILL IS PRESENT AT SOME PROPERTY LINE EXTREMITIES AS A RESULT OF PROPOSED MUNICIPAL
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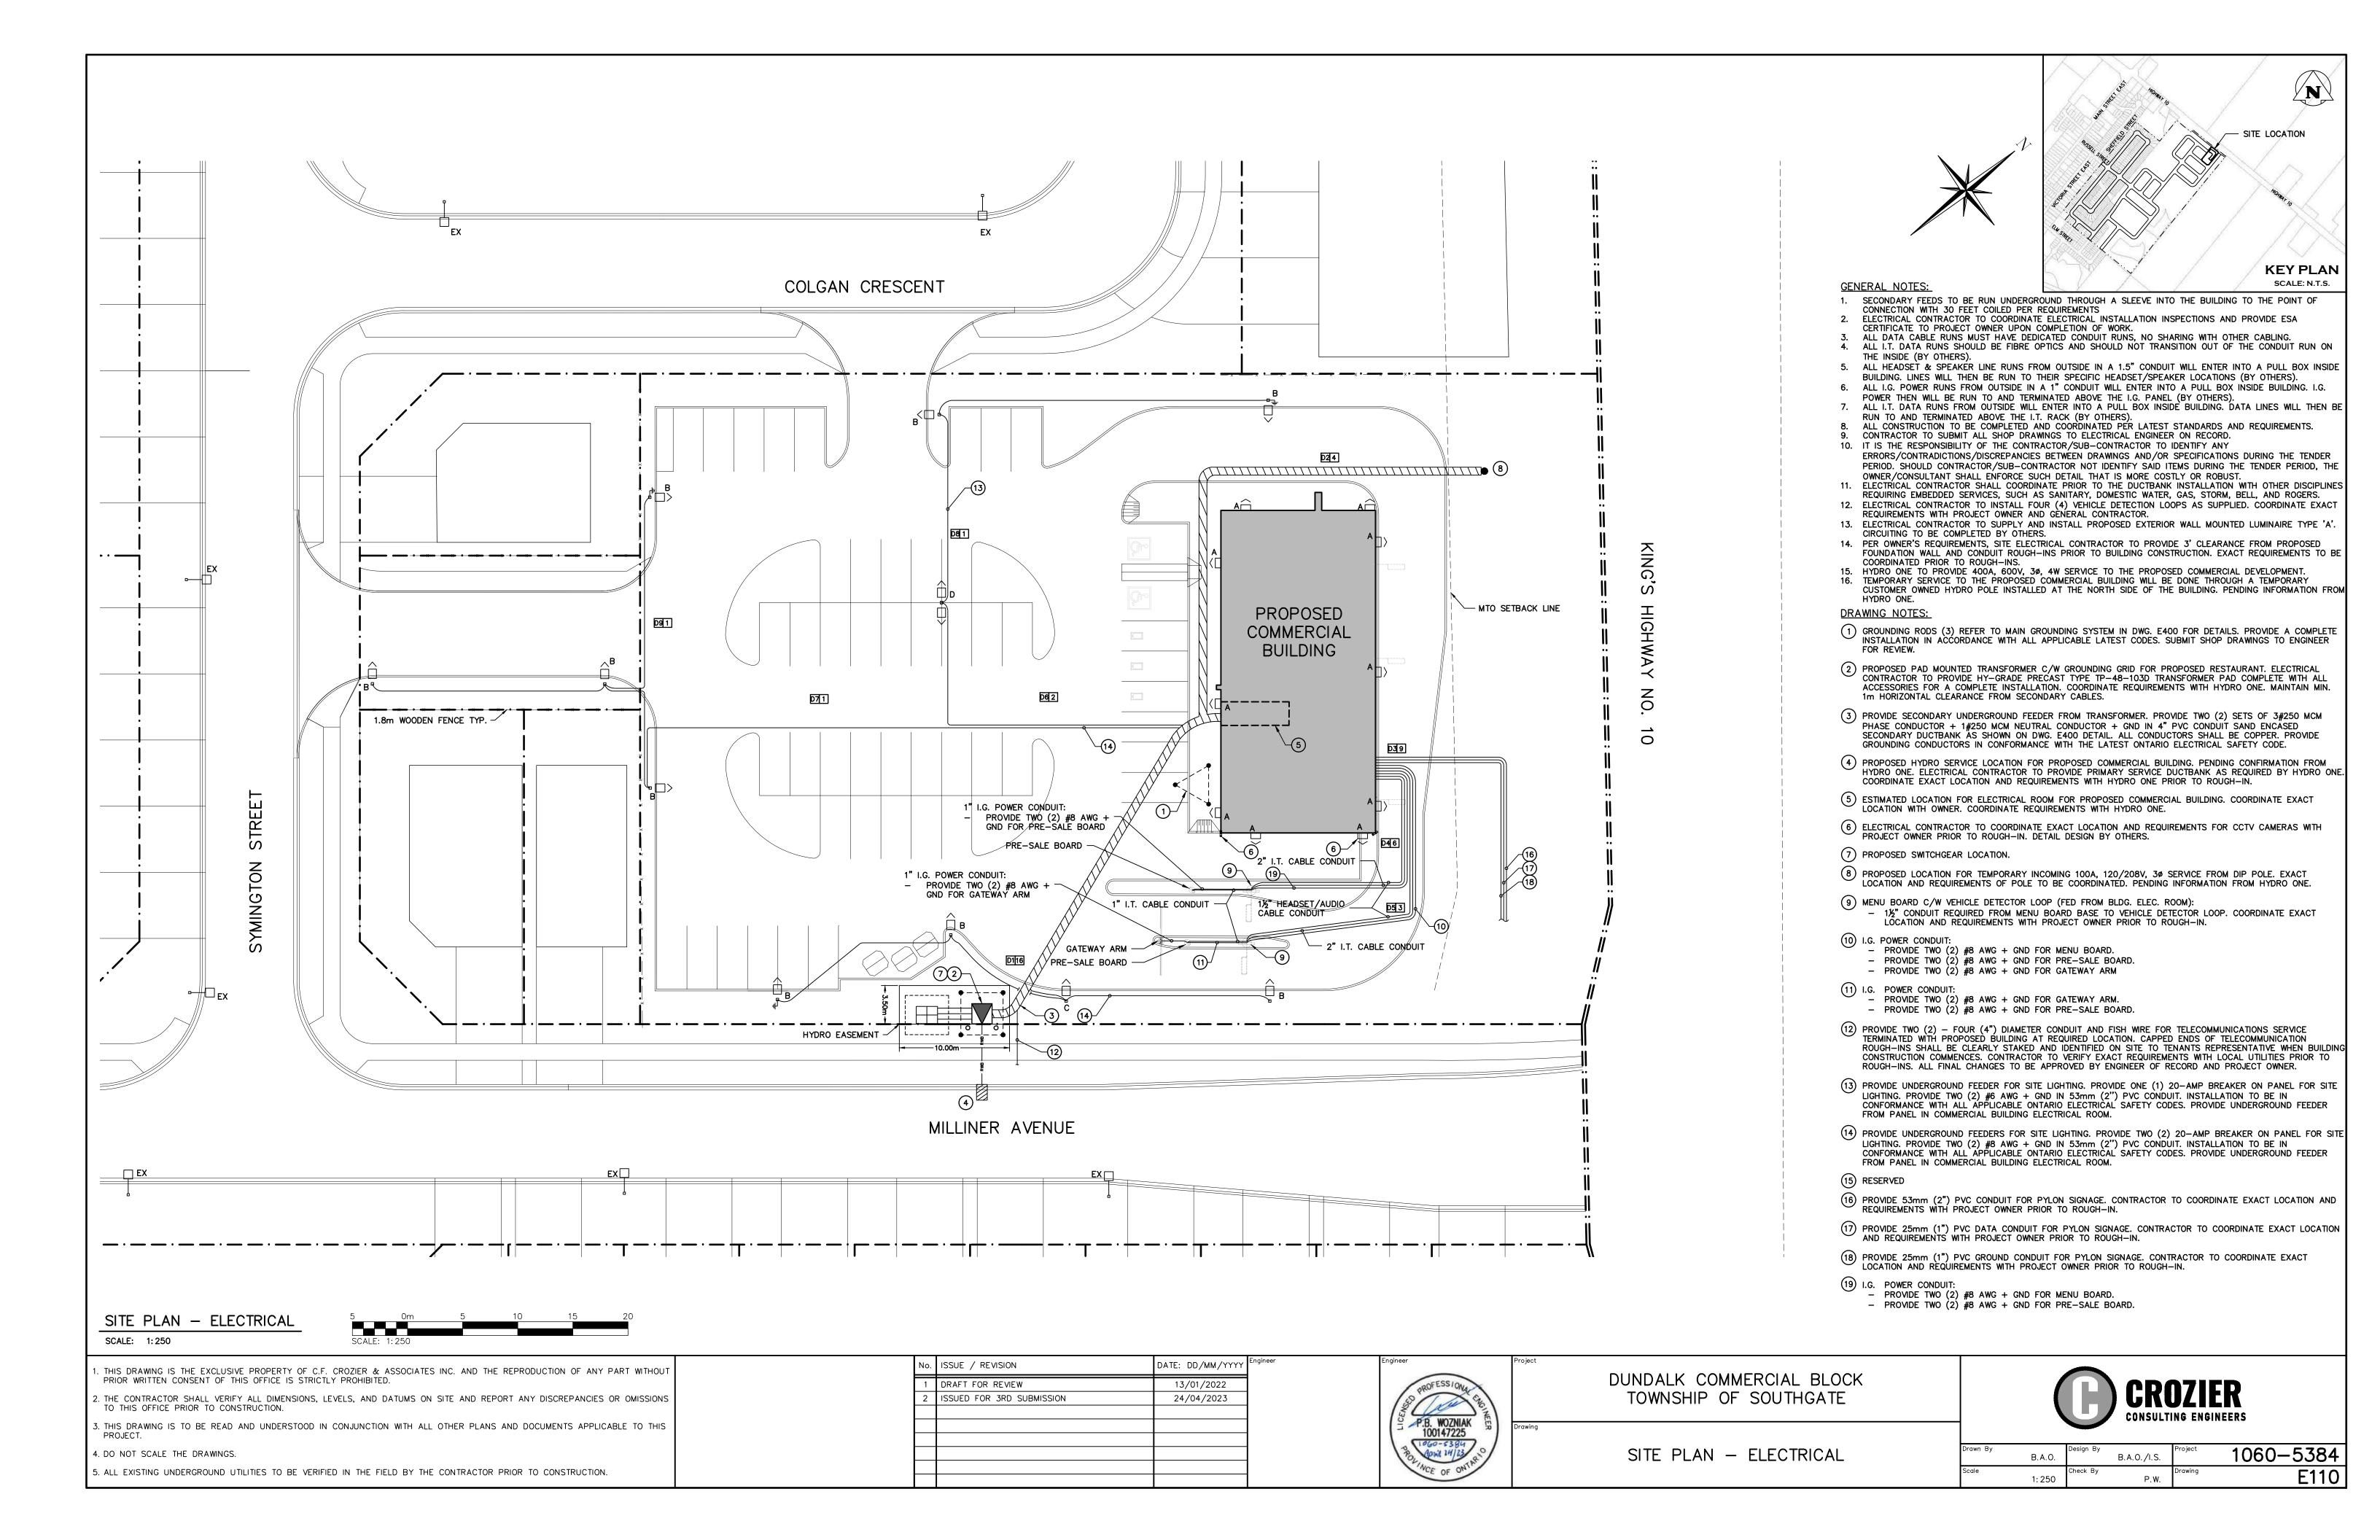



DUNDALK COMMERCIAL BLOCK TOWNSHIP OF SOUTHGATE

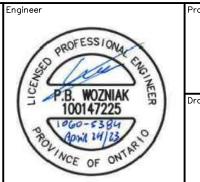SITE LIGHTING DETAILS



1060-5384 B.A.O./I.S.



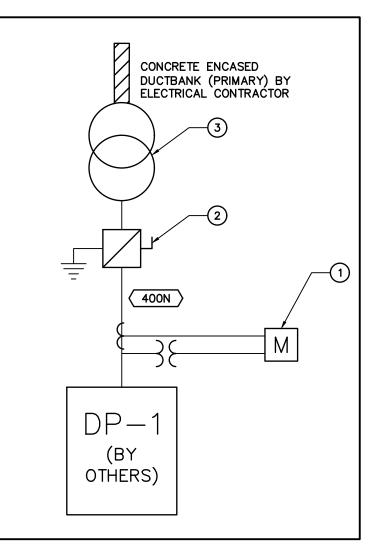

FEEDER SCHEDULE								
FEEDER	AMPACITY	SET(S)	PHASE CONDUCTOR	NEUTRAL	CONDUIT	(INCH)		
400N	400	2	3#250	1#250	103mm	(4")		
FEEDER SCHEDULE NOTE:								


1. ALL CONDUCTORS SHALL BE COPPER.

SINGLE LINE DIAGRAM NOTES:

- 1 ELECTRICAL CONTRACTOR TO PROVIDE AND INSTALL BULK METERING CABINET. COORDINATE EXACT LOCATION AND REQUIREMENTS WITH HYDRO ONE.
- 2 400A, 347/600V, 3ø, 4W, SERVICE RATED MAIN DISCONNECT SWITCH FUSED AT 400A WITH 50kAIC RATING.
- HYDRO ONE PAD-MOUNTED TRANSFORMER. ELECTRICAL CONTRACTOR TO SUPPLY NEMA COMPRESSION SPADES FOR THE SECONDARY CONDUCTORS INSTALLED INTO THE TRANSFORMER VAULT, FOR INSTALLATION BY HYDRO ONE. COORDINATE EXACT LOCATION, REQUIREMENTS AND INSTALLATION WITH HYDRO

SINGLE LINE DIAGRAM

SCALE: N.T.S.

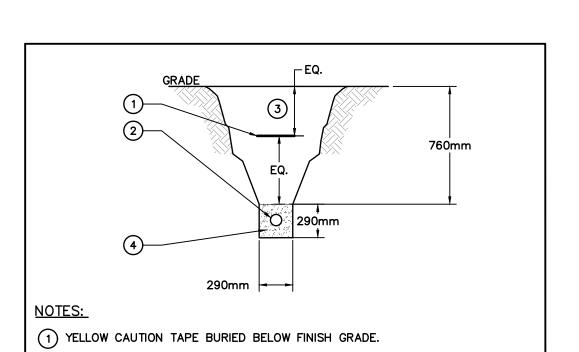


TYPICAL DUCT BANK DETAIL FOR LIGHTING CABLES

3 COMPACTED FILL TO 95% STANDARD PROCTOR MAXIMUM DRY DENSITY.

(2) 50mmø (2") DIAMETER RIGID PVC DUCTS (DB2).


SCALE: N.T.S.

(4) SAND

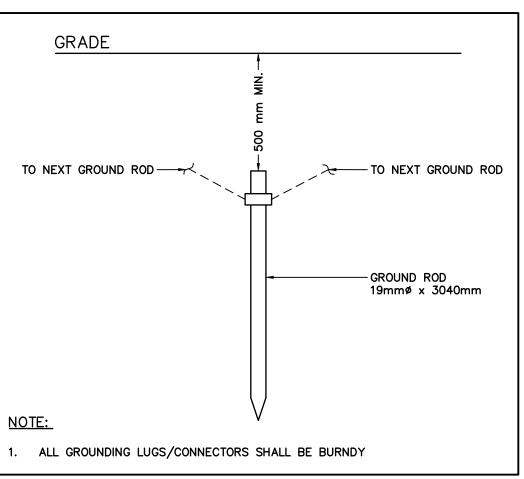


GROUND ROD DETAIL

SCALE: N.T.S.

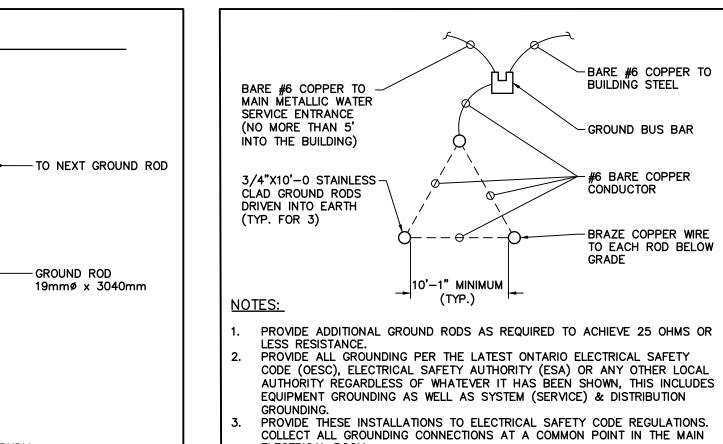

MAIN GROUNDING SYSTEM

SCALE: N.T.S.

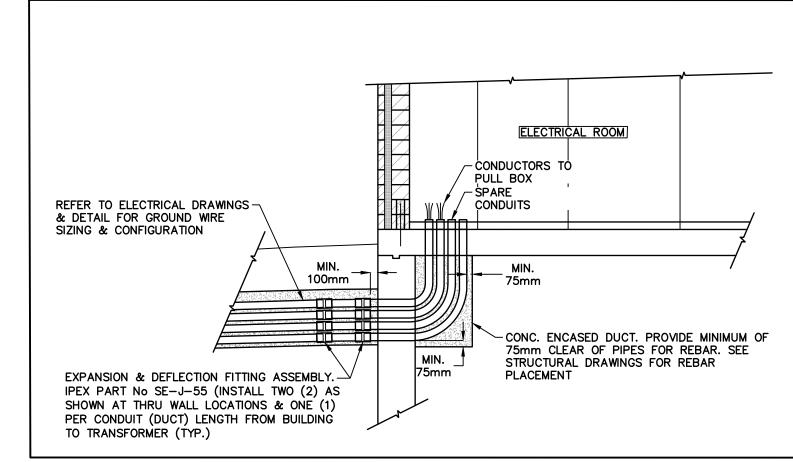


ELECTRICAL DUCTS & BUILDING DETAIL

P.B. WOZNIAK 100147225

1060-5384 April 14/23

SCALE: N.T.S.

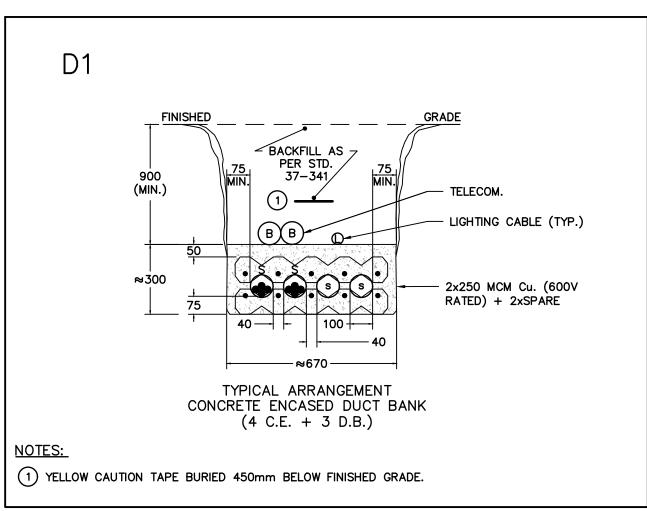

DUCT BANK DETAILS

SCALE: N.T.S.

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DUNDALK COMMERCIAL BLOCK TOWNSHIP OF SOUTHGATE

SINGLE LINE DIAGRAM & SITE ELECTRICAL DETAILS Drawn By



RICAL DETAILS

B.A.O.

B.A.O.

Design By
B.A.O./I.S.

Project
1060-5384

RICAL DETAILS

N.T.S.

Drawing
Project
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E400